CITY OF ANSONIA

ANSONIA HIGH SCHOOL STORAGE BUILDING

20 PULASKI HIGHWAY (CT RT 243) ANSONIA, CT

LIST OF DRAWINGS SHEET NO. TITLE DEMOLITION & EXISTING CONDITIONS SITE PLAN GRADING, UTILITIES & EROSION CONTROL DETAILS

FLOOR PLAN AND ELEVATIONS

MECHANICAL FLOOR PLAN

LOCUS MAP SCALE: 1"=1000'

SILVER / PETRUCELLI + ASSOCIATES ARCHITECTS / ENGINEERS / INTERIOR DESIGNERS 3190 WHITNEY AVENUE HAMDEN, CONNECTICUT 06518-2340 203-230-9007

C1

C2

C3


C4


A100


M100


BID DOCUMENTS MARCH 6, 2020


DONALD W. SMITH, JR., P.E. CONSULTING ENGINEER 56 GREENWOOD CIRCLE SEYMOUR, CONNECTICUT 06483 203-888-4904

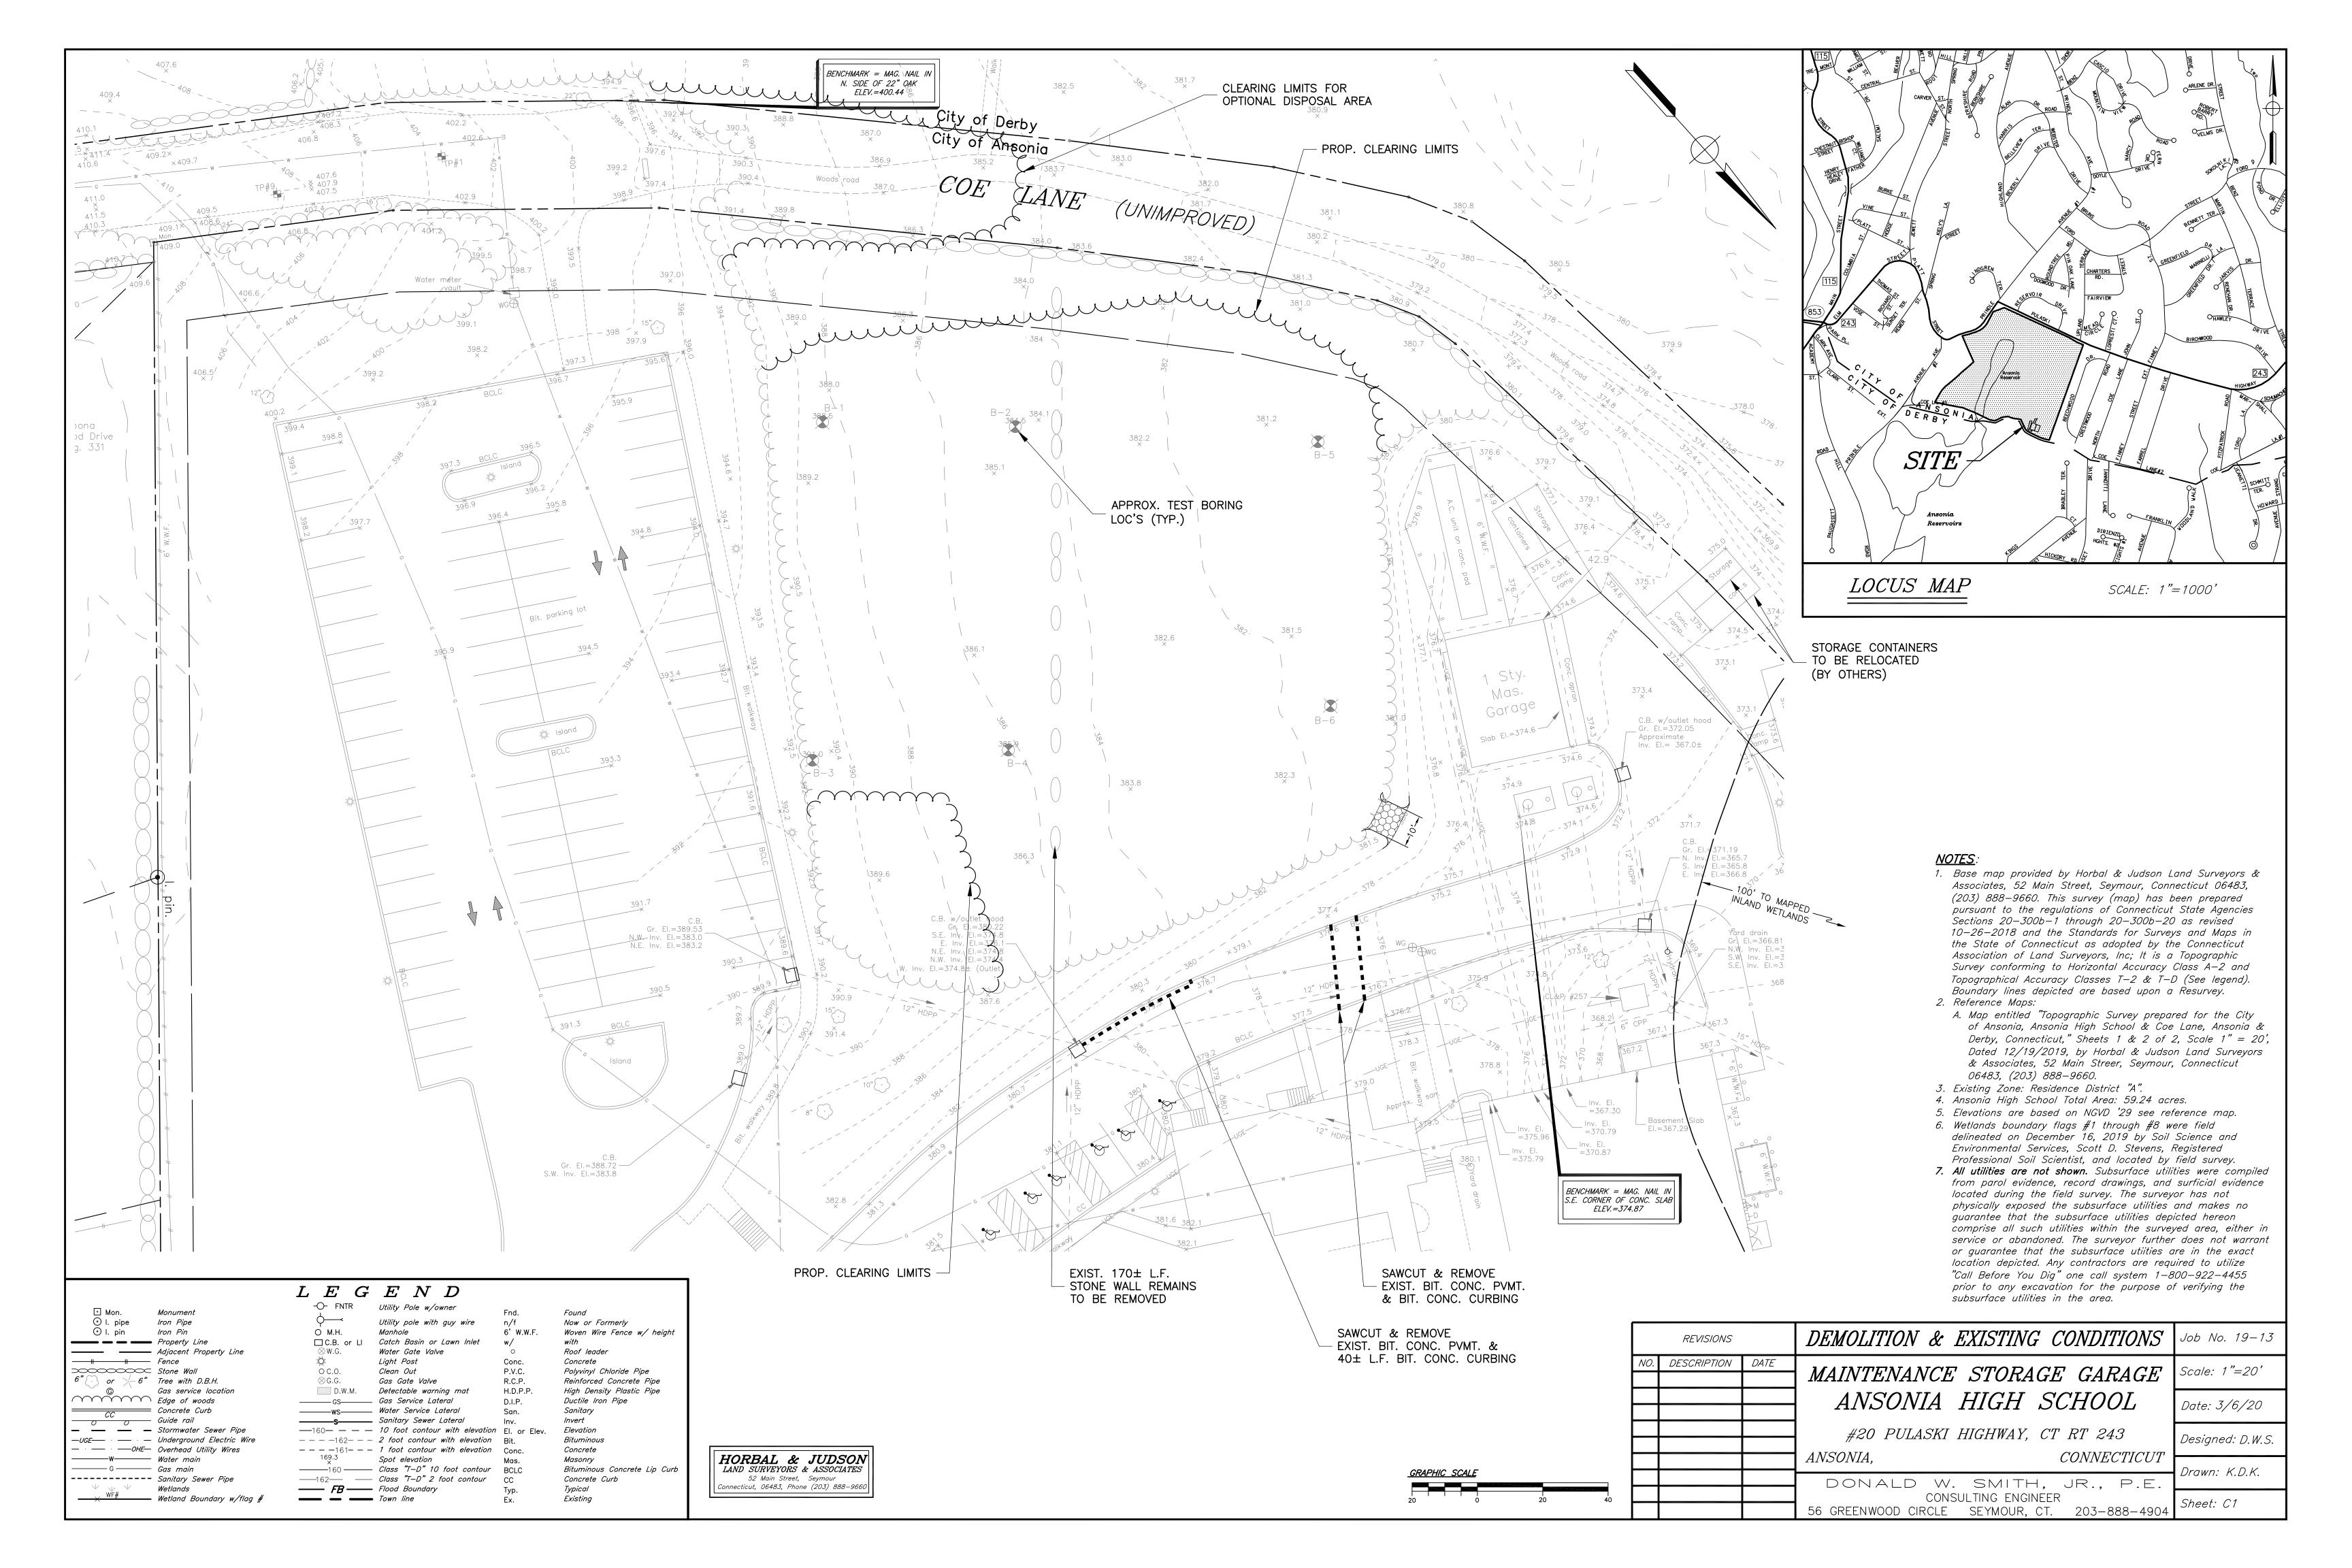

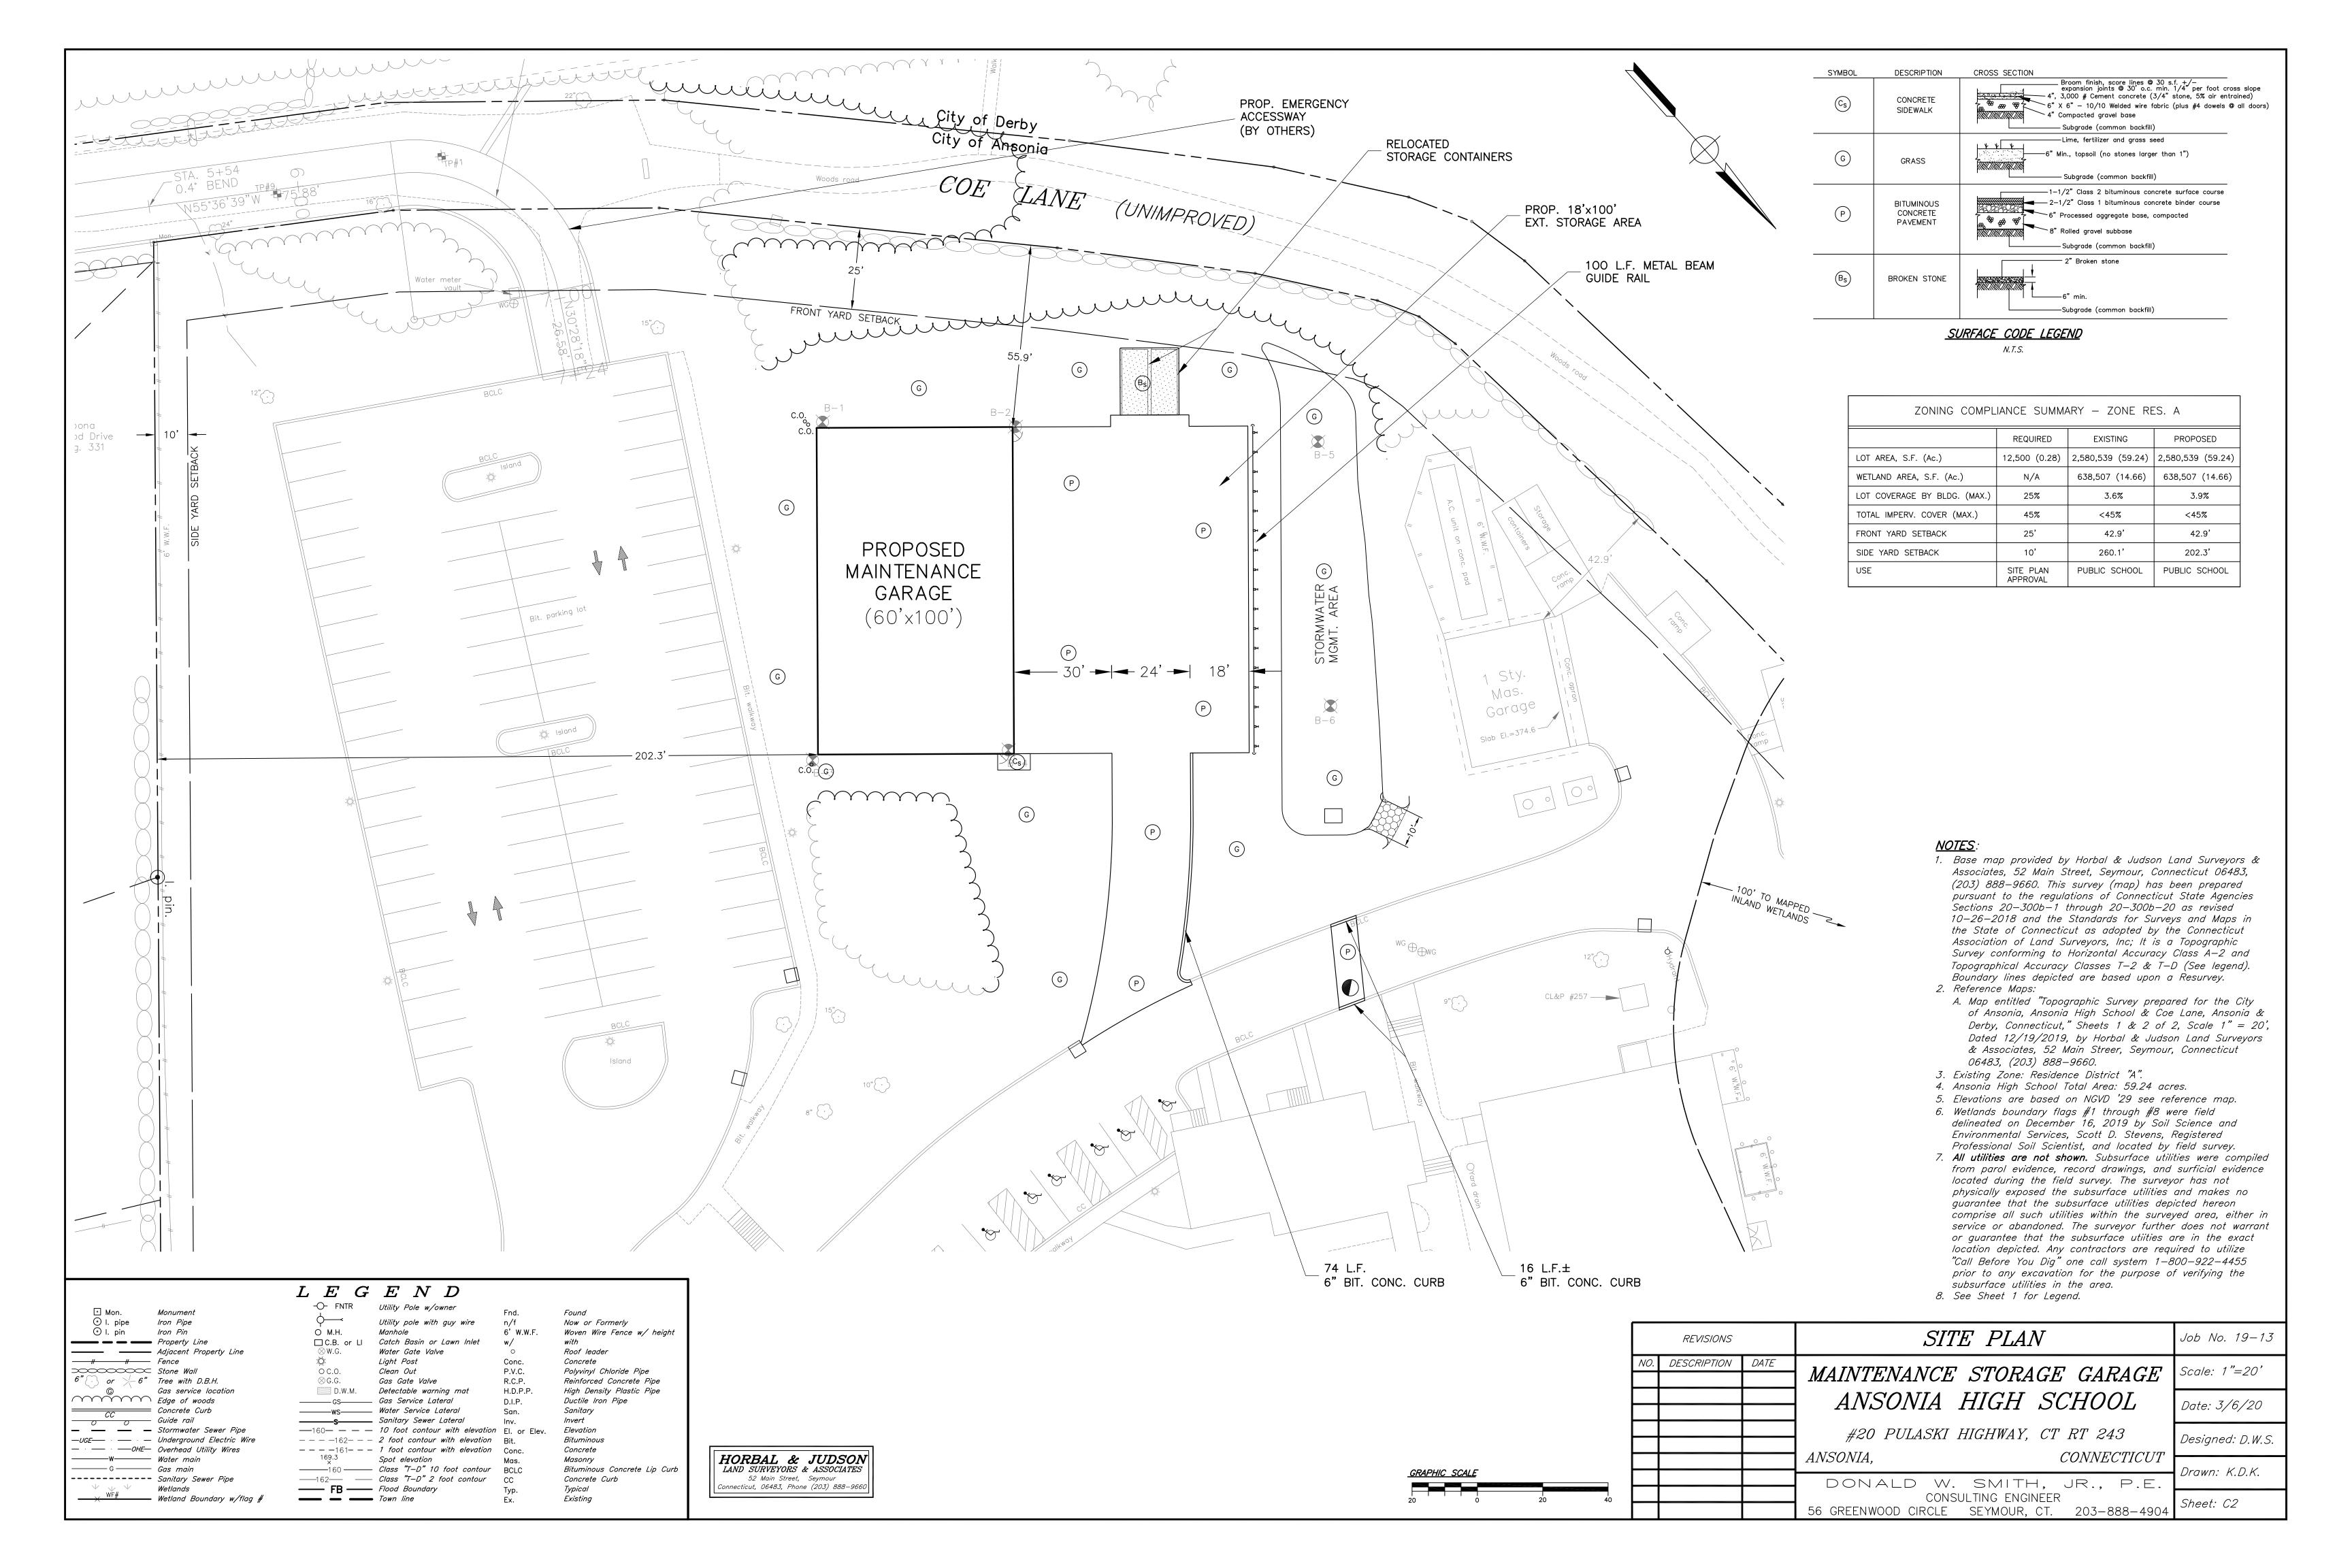

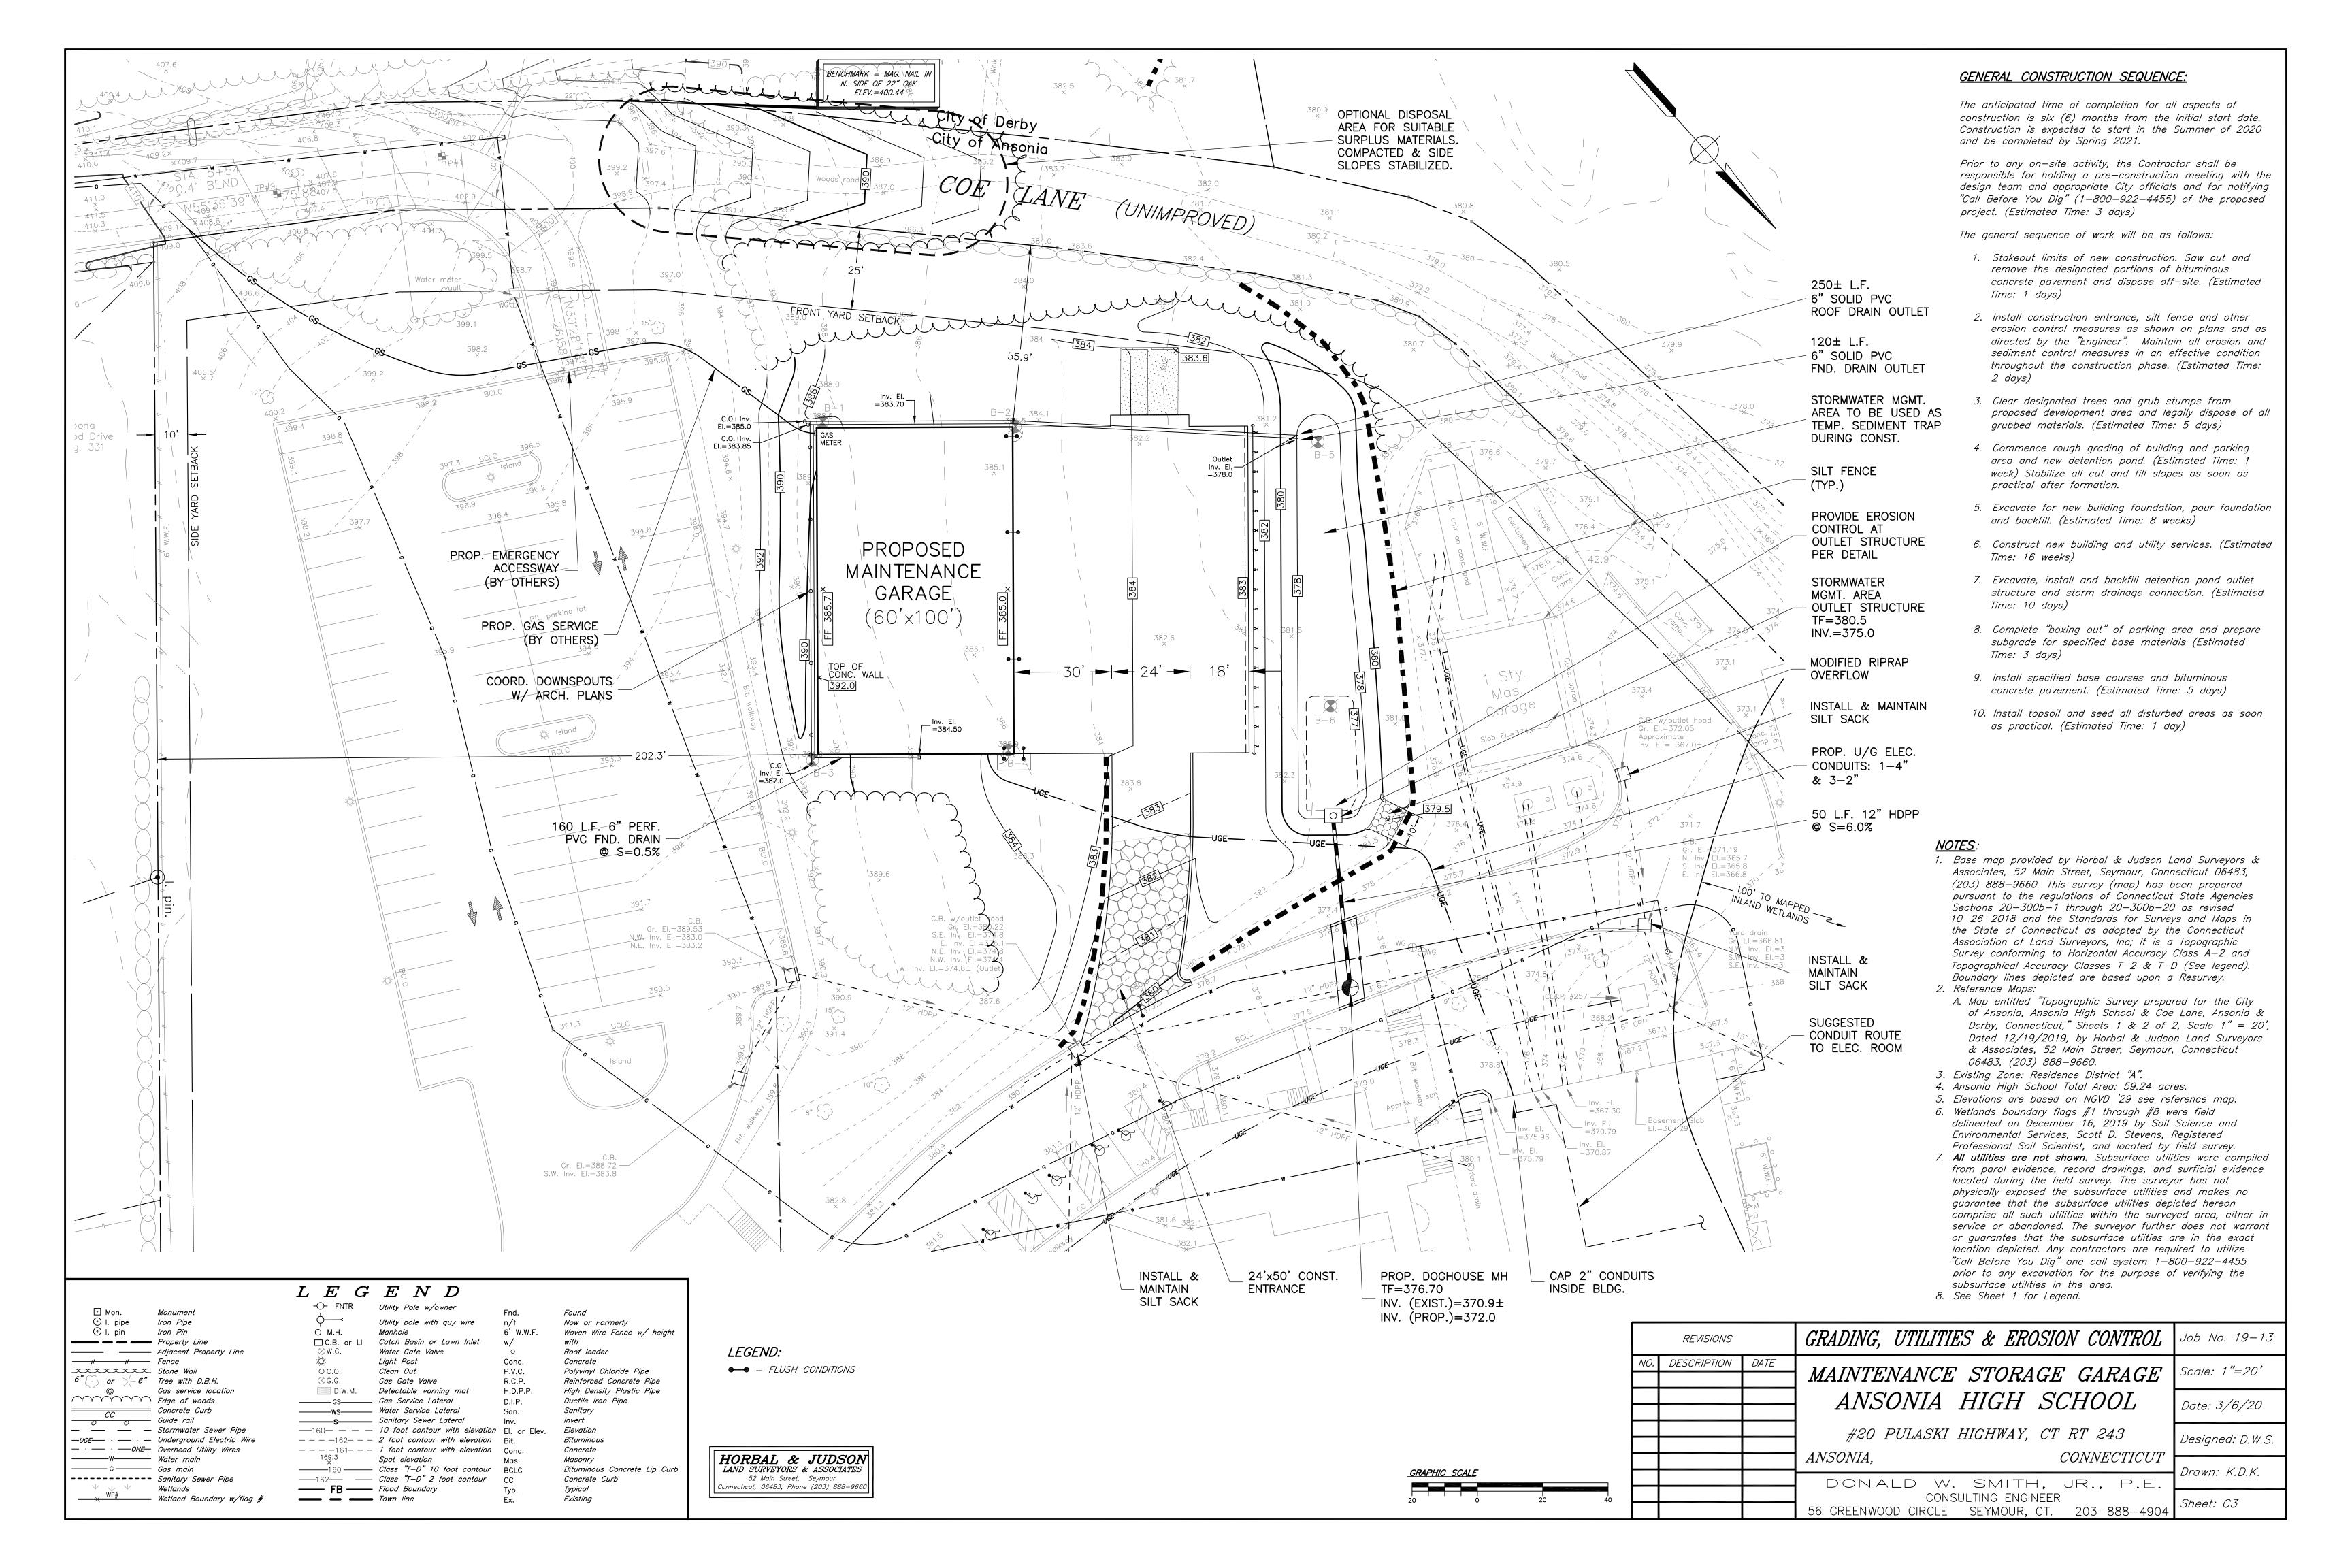

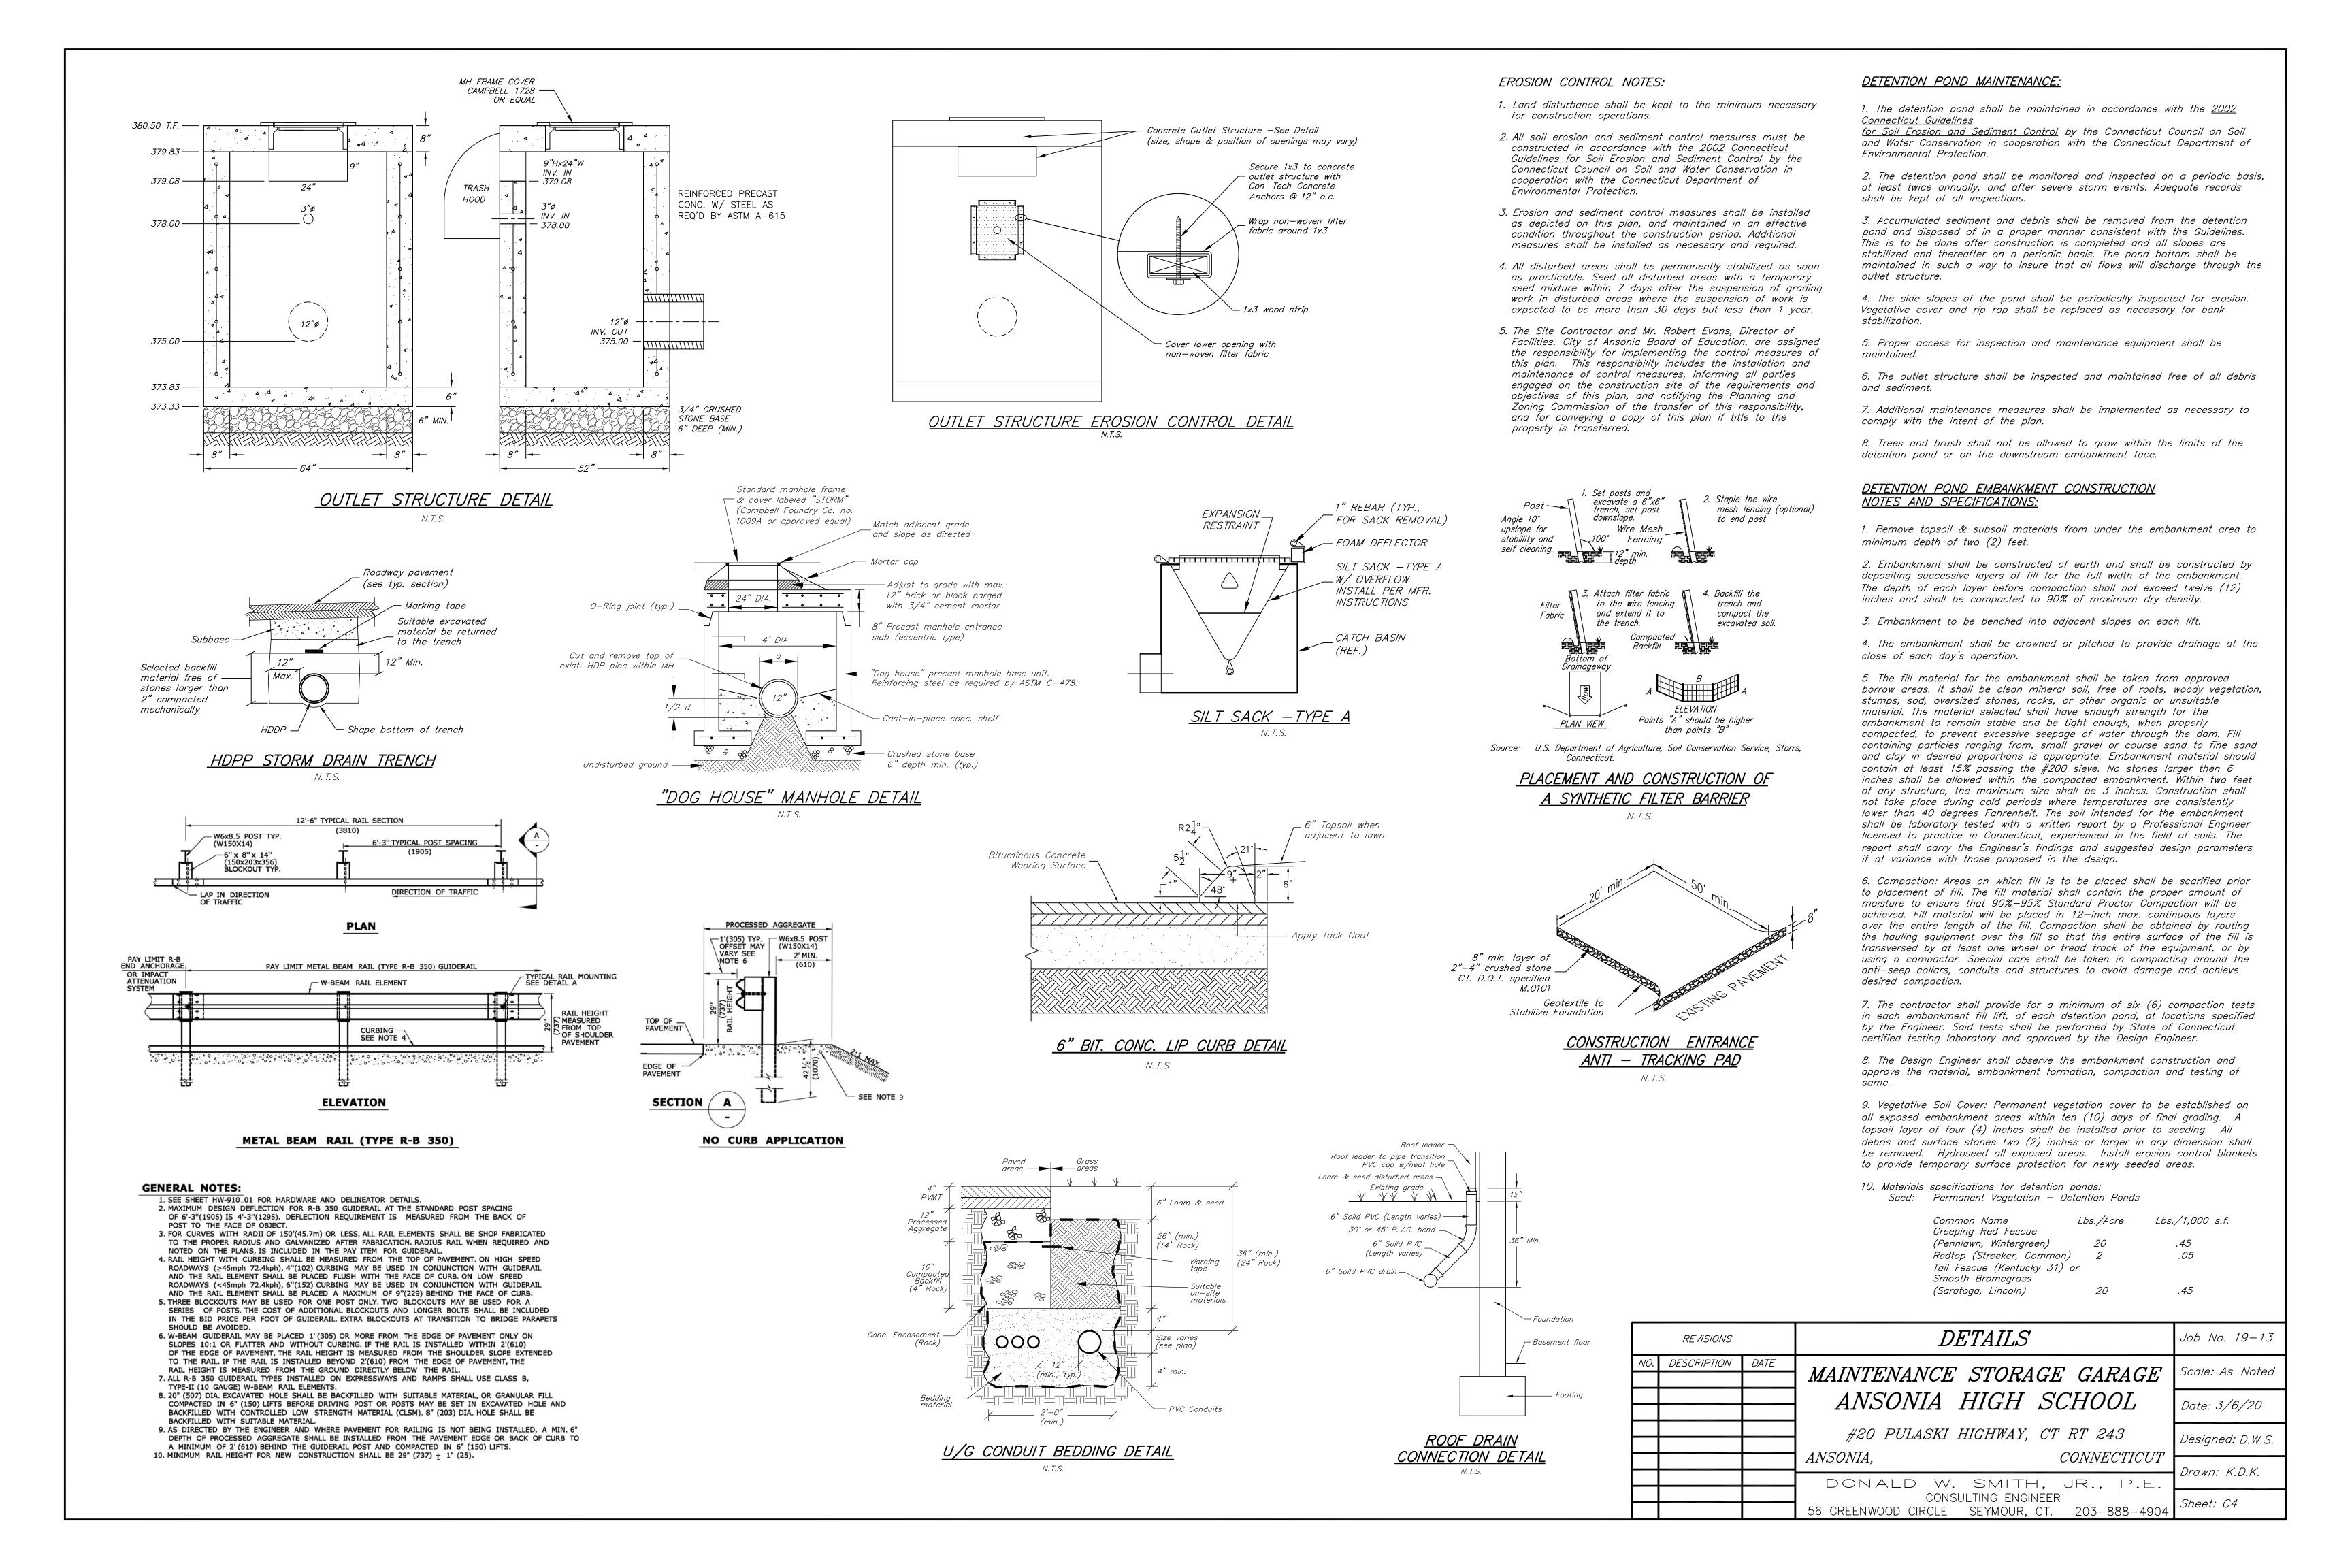


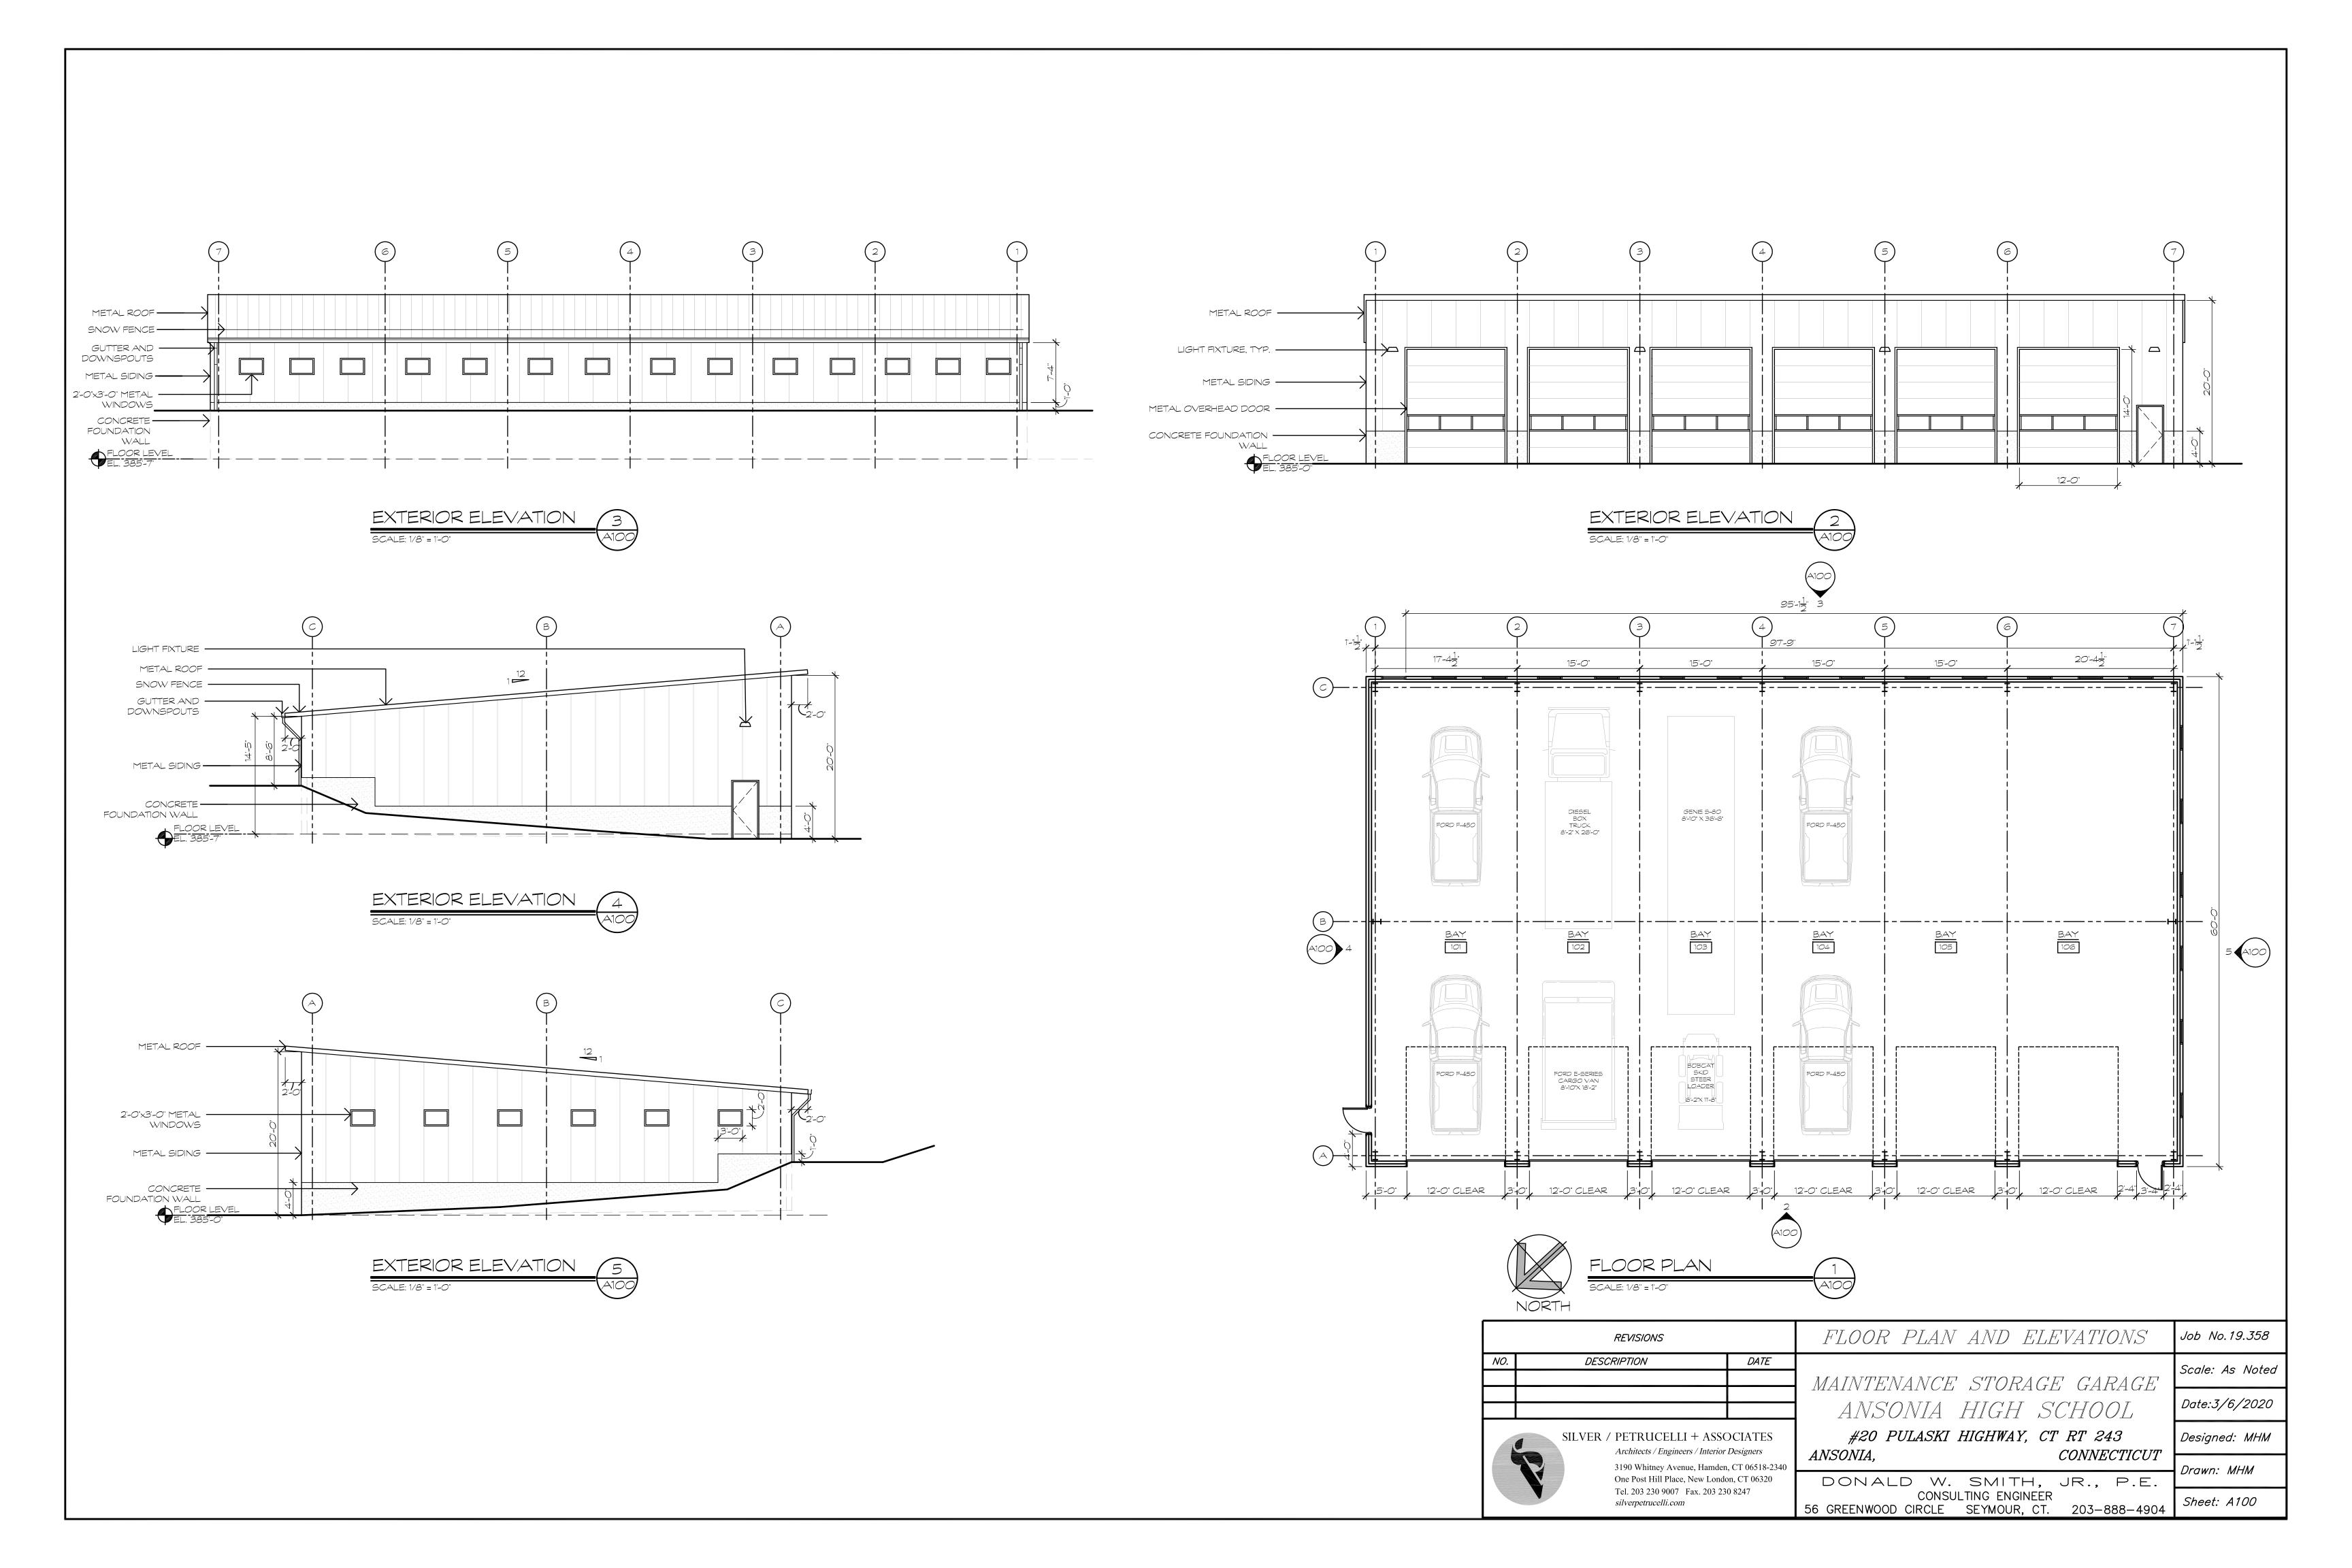


UNIT HEATER SCHEDULE															
SYMBOL	MANUFACTURER & MODEL #	SUPPLY AIR FAN		ELECTRICAL		HEATING							OPER. WEIGHT	REMARKS:	
		MOTOR RPM	MOTOR HP	VOLTS/Ph	TOTAL AMPS	TYPE	INPUT MBH	OUTPUT MBH	EFFICIENC	YCONNECTION GAS (IN)	MINIMUM INLET PRESSURE	MANIFOLD PRESSURE	MAX. MOUNTING HEIGHT (FT)	(LB)	
UH-1	MODINE - HDS125AS0121	1550	1/8	115/1	4.2	NATURAL GAS	125	102,500	82	1/2"	7" WC	3.5 " WC	12'	125	1,2,3,4,5
UH-2	MODINE - HDS125AS0121	1550	1/8	115/1	4.2	NATURAL GAS	125	102,500	82	1/2"	7" WC	3.5 " WC	12'	125	1,2,3,4,5
UH-3	MODINE - HDS60AS0121	1625	1/12	115/1	3.75	NATURAL GAS	60	49,200	82	1/2"	7" WC	3.5 " WC	12'	125	1,2,3,4,5
UH-4	MODINE - HDS60AS0121	1625	1/12	115/1	3.75	NATURAL GAS	60	49,200	82	1/2"	7" WC	3.5 " WC	12'	125	1,2,3,4,5

REMARKS:

- 1. FURNISH WITH MOTOR WITH INTERNAL THERMAL OVERLOAD PROTECTION.
- 2. DISCONNECT SWITCH SHALL BE PROVIDED BY DIVISION 16.
- 3. PROVIDE WITH FACTORY MOUNTED FAN AND TEMPERATURE CONTROL .
- 4. PROVIDE WITH FACTORY INSTALLED FAN GUARD.
- 5. PROVIDE WITH FACTORY TRANSFORMER 115V TO 24V

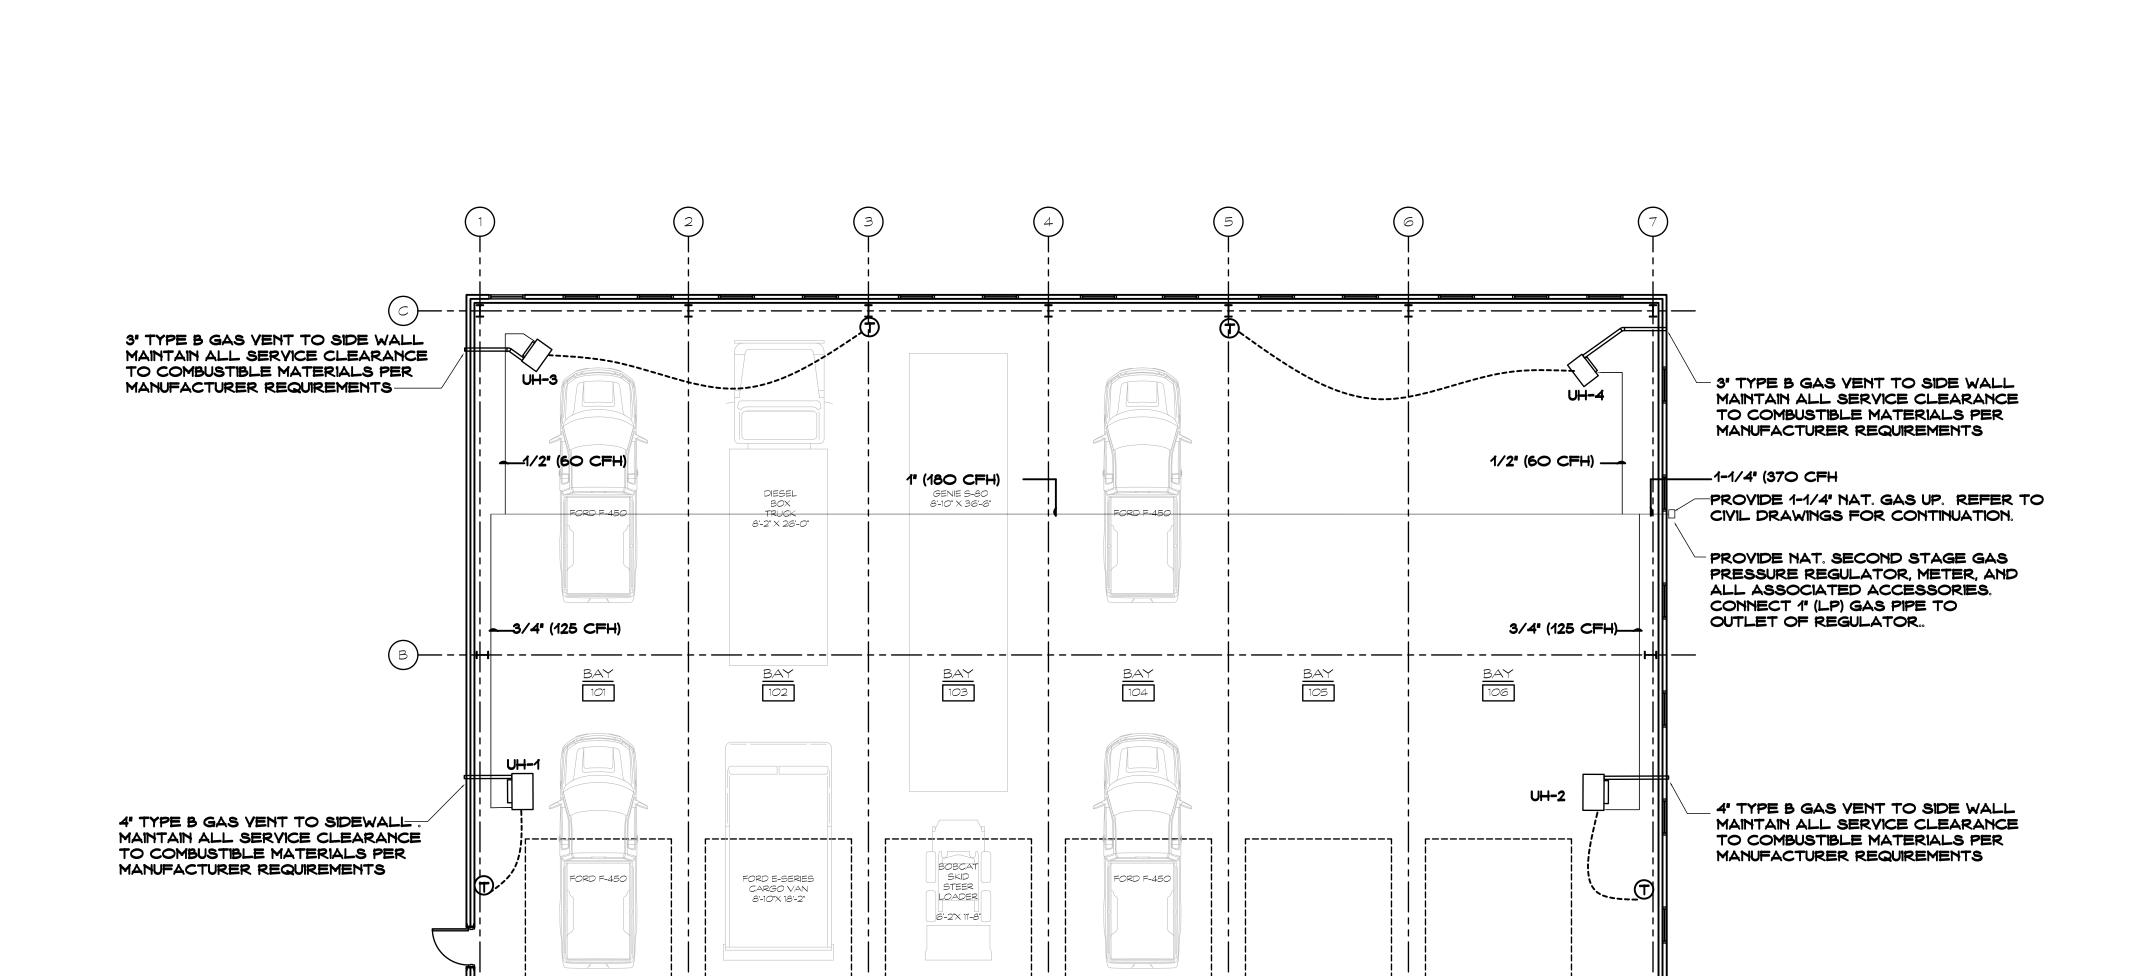



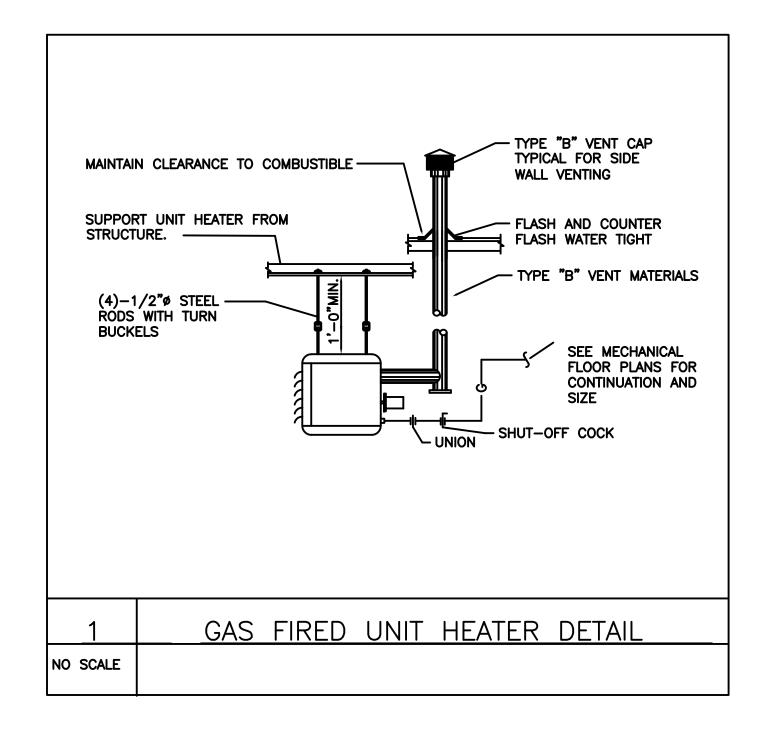

GENERAL DESIGN/BUILD PERFORMANCE NOTES:

- 1. THE INTENT OF THESE CONTRACT DOCUMENTS IS FOR THE CONTRACTOR TO FURNISH AND INSTALL COMPLETE MECHANICAL SYSTEMS. THE MECHANICAL SYSTEM TO BE DESIGN/BUILD BY MECHANICAL CONTRACTOR. MECHANICAL SYSTEM TO BE INSTALLED BY A LICENSED MECHANICAL CONTRACTOR. VERIFY EQUIPMENT TYPE WITH OWNER PRIOR TO PURCHASE AND INSTALLATION.
- 2. PROVIDE SUPPORT/BRACING OF EQUIPMENT AND BUILDING SERVICES FOR SEISMIC RESTRAINT AS REQUIRED BY CODE.
- 3. OBTAIN AND PAY FOR ALL REQUIRED PERMITS AND INSPECTIONS.
- 4. ALL WORK SHALL BE PERFORMED IN COMPLIANCE WITH THE APPLICABLE CODES IN THE ORDINANCES AND THE REGULATORY AGENCIES HAVING JURISDICTION.
- 5. COORDINATE ALL PIPING AND CONDUITS LEAVING THE BUILDING WITH THE SITE CONTRACTOR(S) BEFORE INSTALLATION.
- 6. ALL TEMPERATURE CONTROLS, SHALL BE LOCATED IN ACCESSIBLE LOCATIONS.
- 7. CONTRACTOR SHALL VERIFY LOCATION OF ALL EXISTING UNDERGROUND UTILITIES PRIOR TO
- 8. ALL EQUIPMENT, PIPING, SHALL BE SUPPORTED AS DETAILED, AND REQUIRED TO PROVIDE A VIBRATION FREE INSTALLATION.

VISIO.	NS		MECHANICAL FLOOR PLAN	Job No.19.358	
VO.	DESCRIPTION	DATE	MAINTENANCE STORAGE GARAGE	Scale: As Noted	
			ANSONIA HIGH SCHOOL	Date: 3/6/2020	
SILVER / PETRUCELLI + ASSOCIATES Architects / Engineers / Interior Designers			#20 PULASKI HIGHWAY, CT RT 243 ANSONIA. CONNECTICUT	Designed: RL	
	3190 Whitney Avenue, Hamden, One Post Hill Place, New London	n, CT 06320	DONALD W. SMITH, JR., P.E.	Drawn: RL	
	Tel. 203 230 9007 Fax. 203 230 silverpetrucelli.com		CONSULTING ENGINEER 56 GREENWOOD CIRCLE SEYMOUR, CT. 203-888-4904	Sheet: M100	